

IMPERVIOUS COVERAGE CALCULATIONS

NEW IMPERVIOUS SURFACE - 1,131 SQ. FT.

PER SECTION 455-17.A (3) FOR EACH NEW SQUARE FOOT OF NEW IMPERVIOUS SURFACE, TWO GALLONS OF STORM WATER SHALL BE MANAGED,

1,131 SQ. FT. OF NEW IMPERVIOUS = 2,262 GAL. = 303 CU. FT. OF WATER TO BE COLLECTED.

SEEPAGE PIT CALCULATIONS

SEEPAGE PIT TYPE 'A' CALCULATIONS

8' Diameter 4' Deep 2' Stone Around Pit / 2' Stone at Bottom of Pit

<u>Pit Volume</u> = 172 cf

Stone Around Pit

STONE $\phi = 12'$

2' OF STONE, 40% VOIDS

INNER $\phi = 7.3'$

OUTER Ø = 8'

Ø.4(4')/π)/12²-8²)


Stone at Bottom

2' OF STONE, 40% VOIDS Ø.4(2' χ πχ 12²/4)

= 90 cf TOTAL VOLUME = 362.5 cf


SUMMARY

CU. FT. COLLECTED > CU. FT. REQUIRED 362.5 CU, FT. COLLECTED > 303.0 CU. FT. REQUIRED

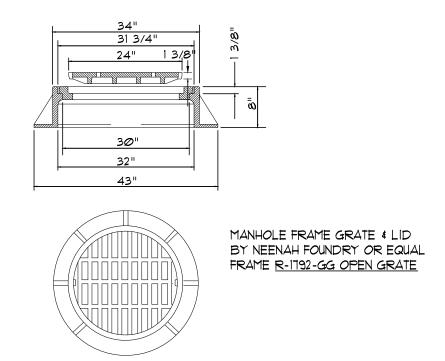

MANHOLE DETAIL

SCALE: 1/2" = 1'-0"

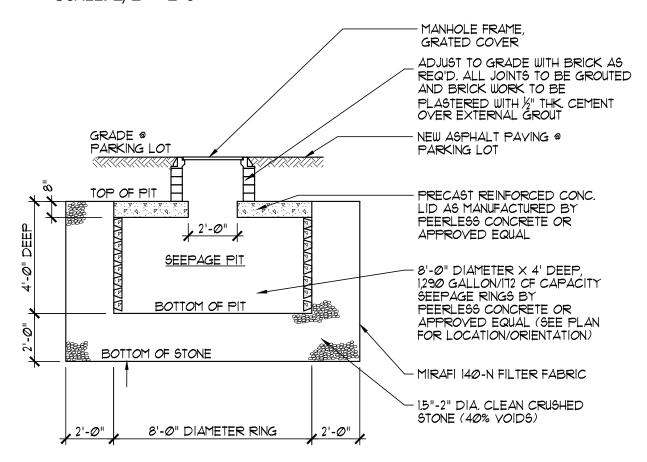

NOTE:

THE OWNER WILL BE RESPONSIBLE FOR THE MAINTENANCE AND LIABILITY OF THE SEEPAGE PIT. SEEPAGE PIT SHALL BE INSPECTED AFTER INTENSE RAINFALL EVENTS. DEBRIS AND SEDIMENT SHALL BE REMOVED ANNUALLY, DURING DRY AND WARM WEATHER. SEE STORM WATER MAINTENANCE PLAN ON


- THIS PLAN.

 2. AN INSPECTION OF THE EXCAVATION SHALL BE MADE BY THE TOWNSHIP ENGINEER PRIOR TO INSTALLATION OF THE SEEPAGE PITS.

 3. TEST PITS WILL BE PERFORM PRIOR TO THE INSTALLATION OF SEEPAGE PITS TO DETERMINE PERMEABILITY AND GROUND WATER DEPTHS

SEEPAGE PIT DETAIL

SCALE: 1/4" = 1'-0"

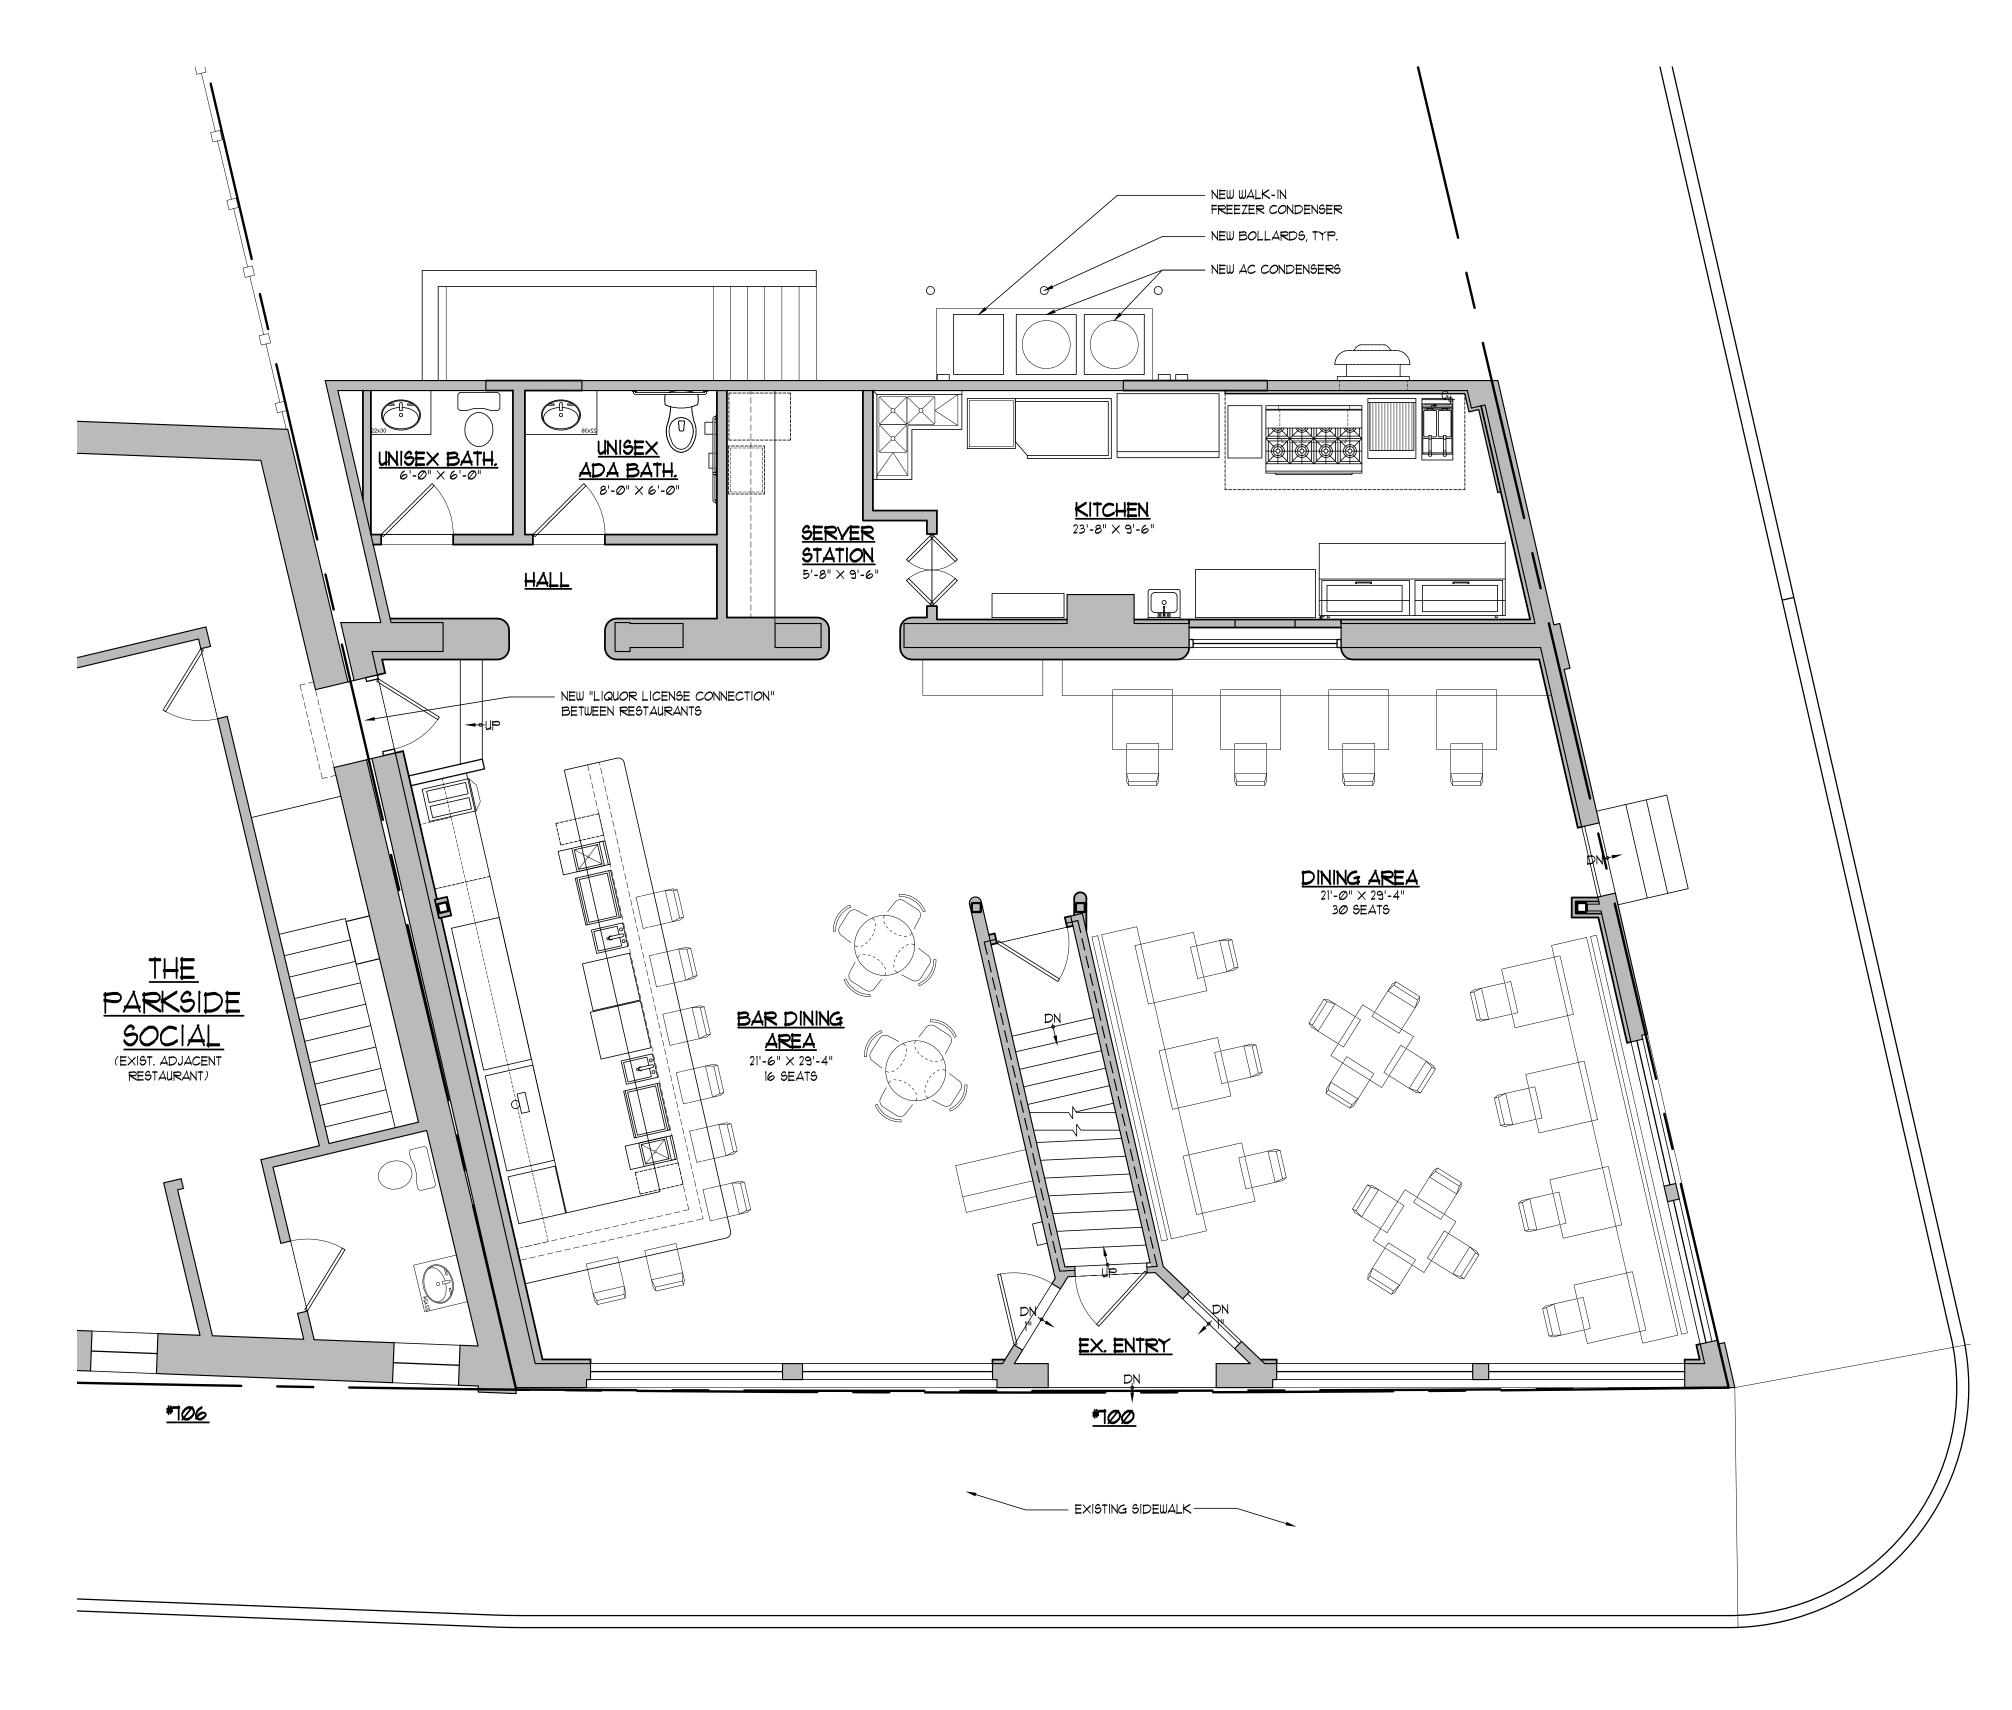

FIRST FLOOR PLAN SCALE: 1/4" = 1'-0"

Proposed Restaurant Below Existing (2) Residential Units Located at: 700 Bloomfield Avenue Verona, NJ Block: 1606 Lot: 13

AREA CALCULATIONS


700 BLOOMFIELD AVE

<u>BASEMENT:</u> 2,10/3 SQ. FT.

FIRST FLOOR: 2,103 SQ. FT.

FIRST FLOOR: 1,620 SQ. FT.

REVIEW SET 05/28/2024

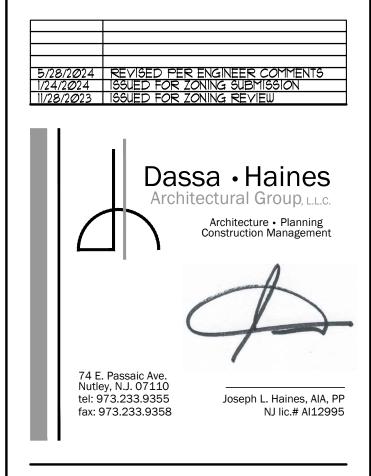


| First Floor Plan | |
|-------------------------|----|
| TE: 11/28/2 0 23 | |
| ALE: AS SHOWN | 77 |

2 of 3

JOB # 23-113


DRAWN BY: CHECKED BY:

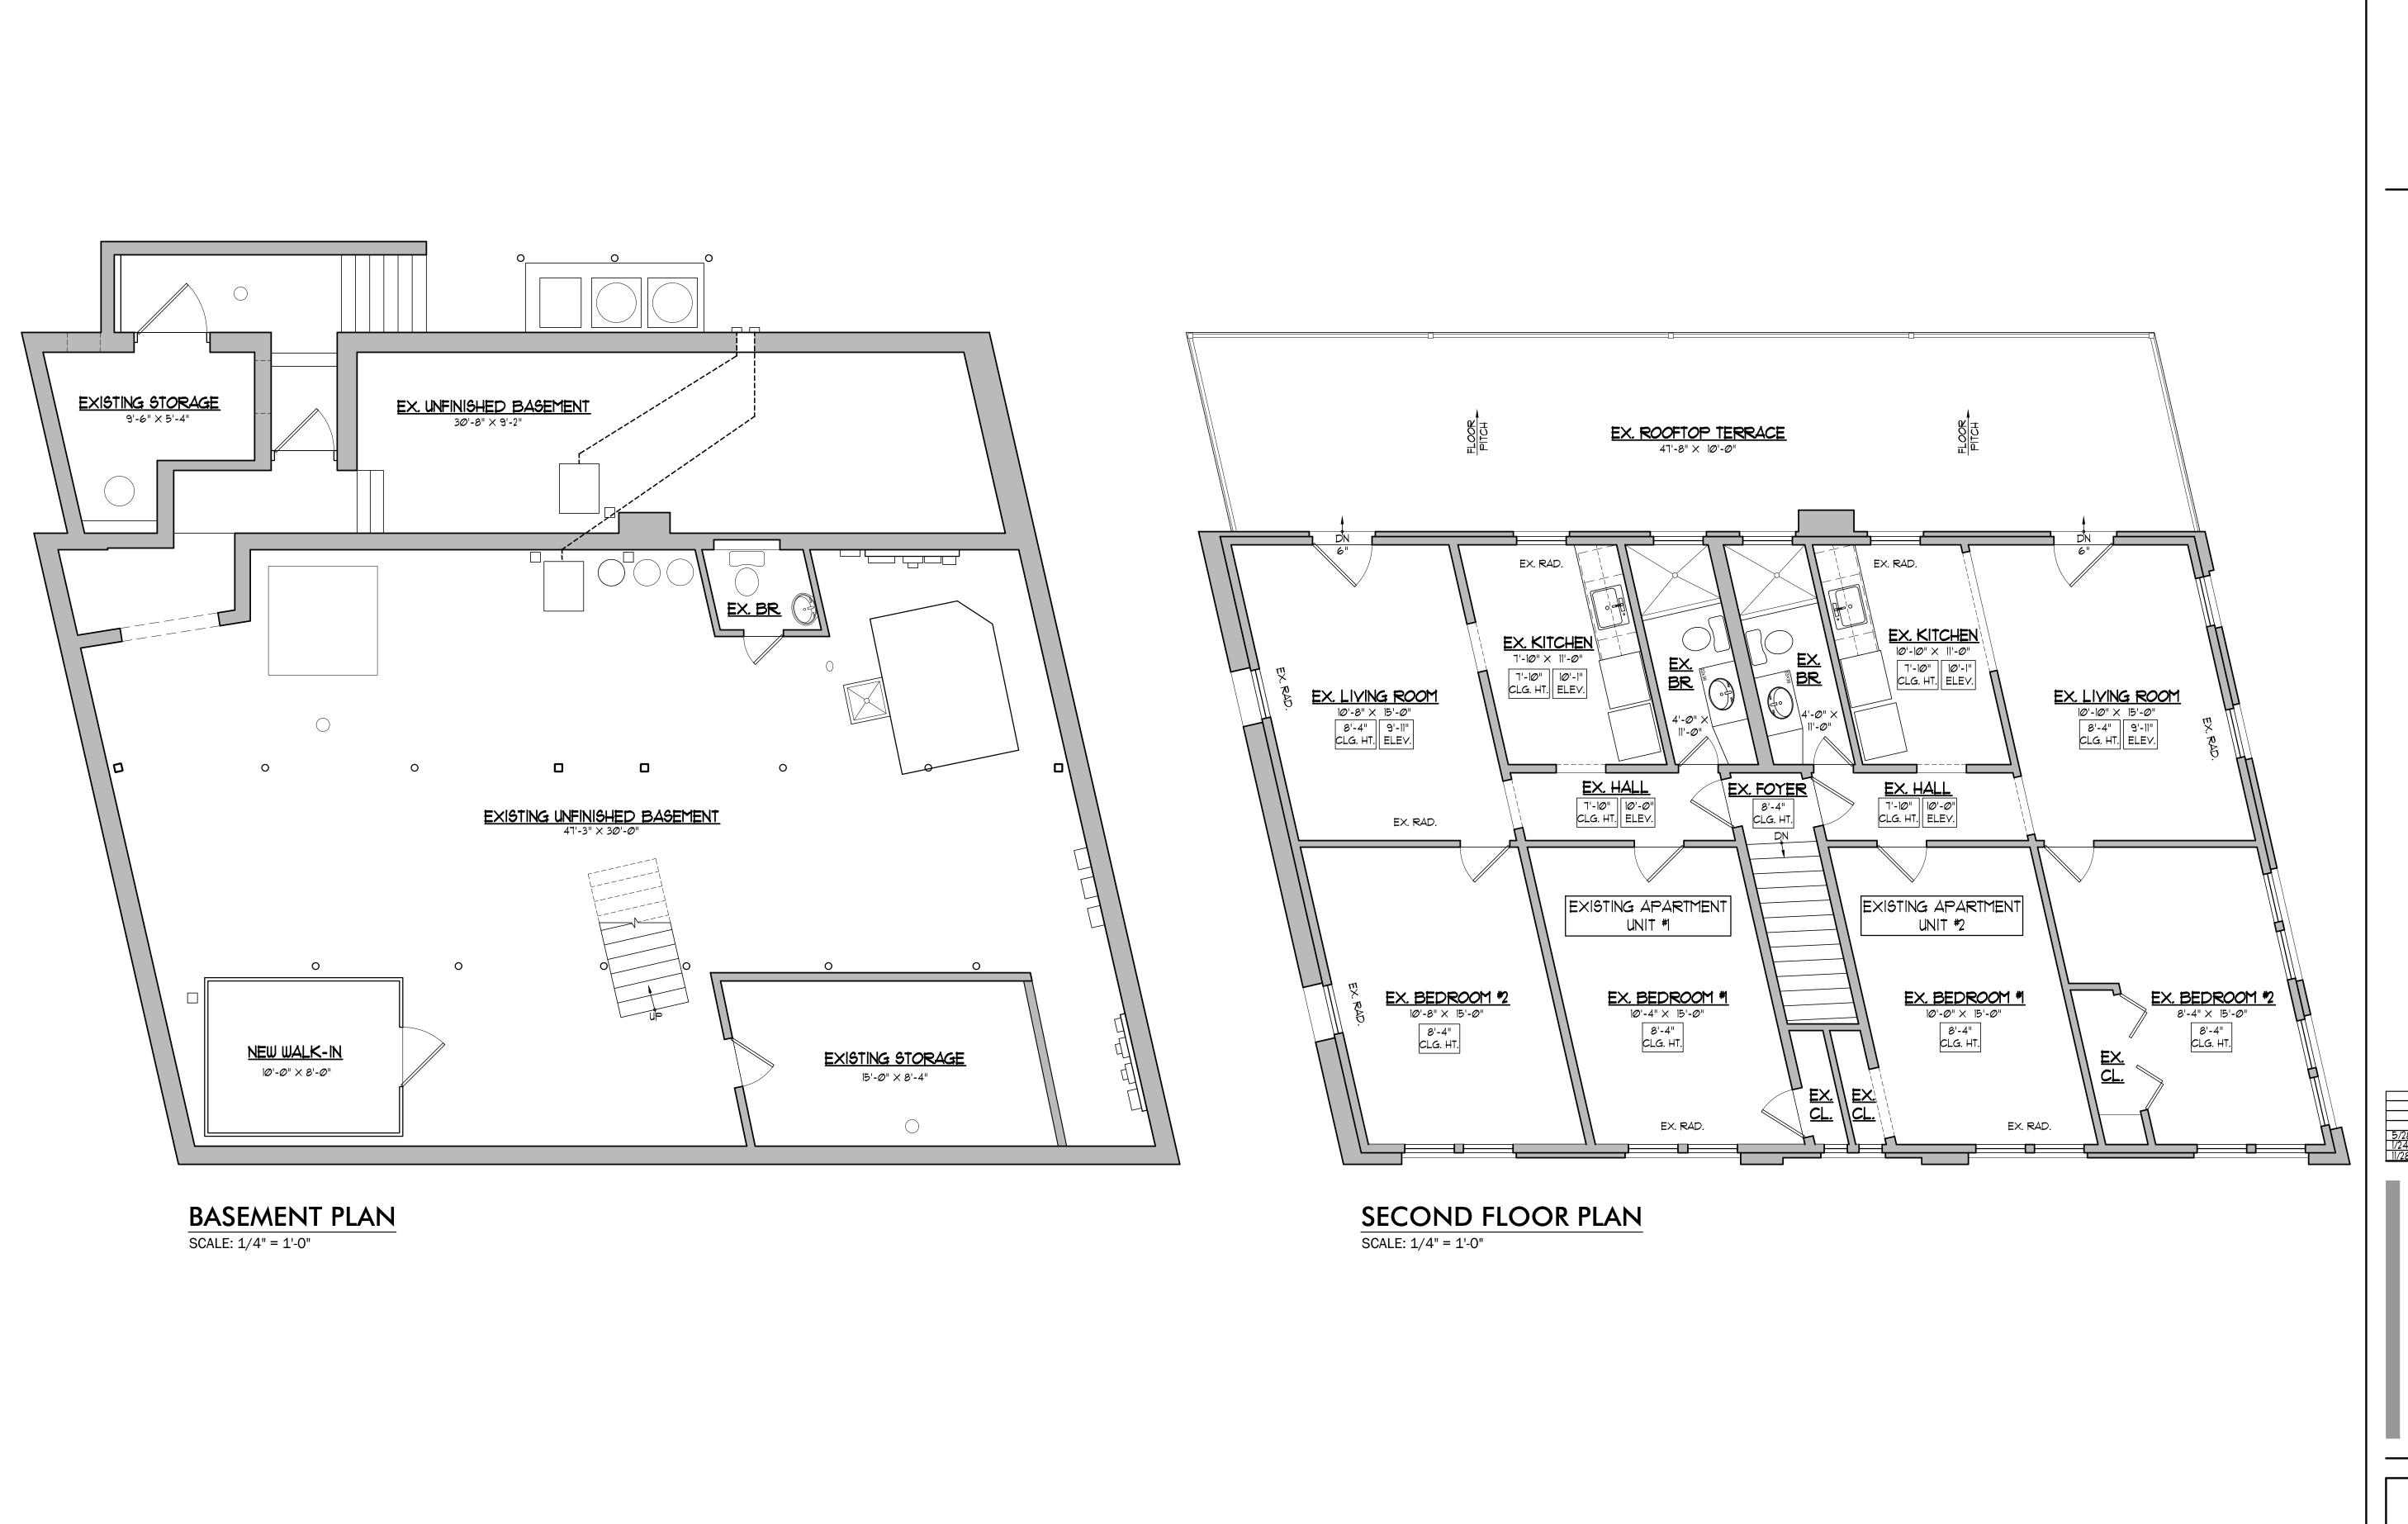

Proposed Restaurant
Below Existing (2)
Residential Units
Located at:
700 Bloomfield Avenue
Verona, NJ
Block: 1606 Lot: 13

REVIEW SET 05/28/2024

5/28/2024 REVISED PER ENGINEER COMMENTS
1/24/2024 ISSUED FOR ZONING SUBMISSION
1/24/2023 ISSUED FOR ZONING PENGEN

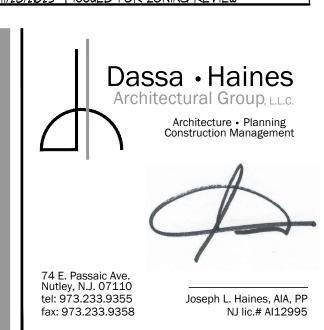

Basement & Second Floor Plans

DATE: 11/28/2023

SCALE: AS SHOWN

JOB # 23-113

BIN:

DRAWN BY: CHECKED BY: Jih 3 OF 3